


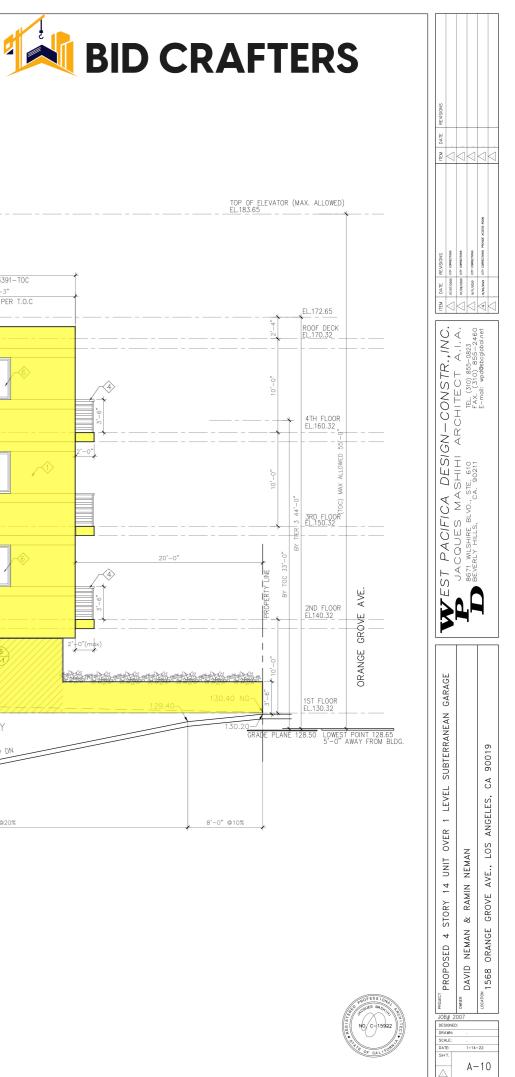


Wood Siding Stucco Graffti Resistant Finish 42" High Steel Railing Gas Meter











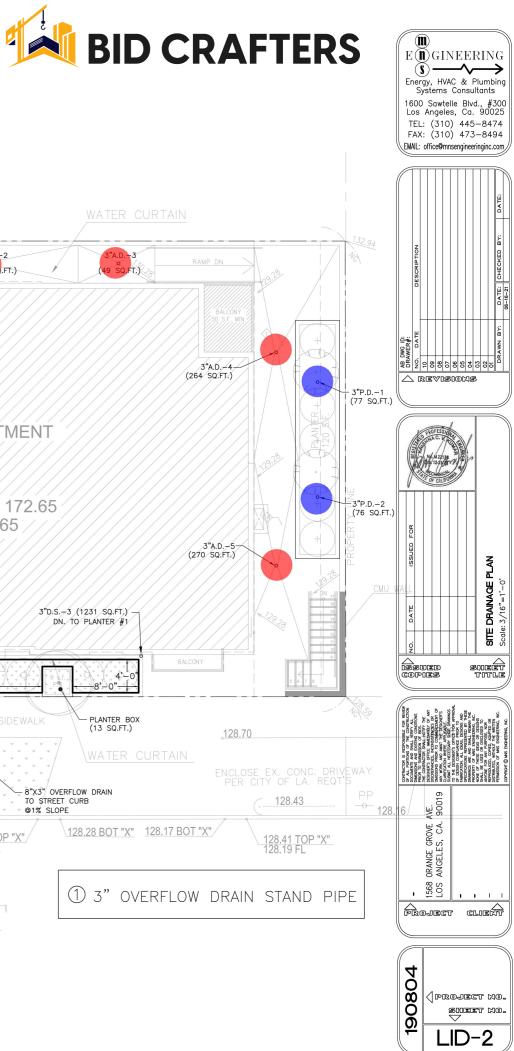

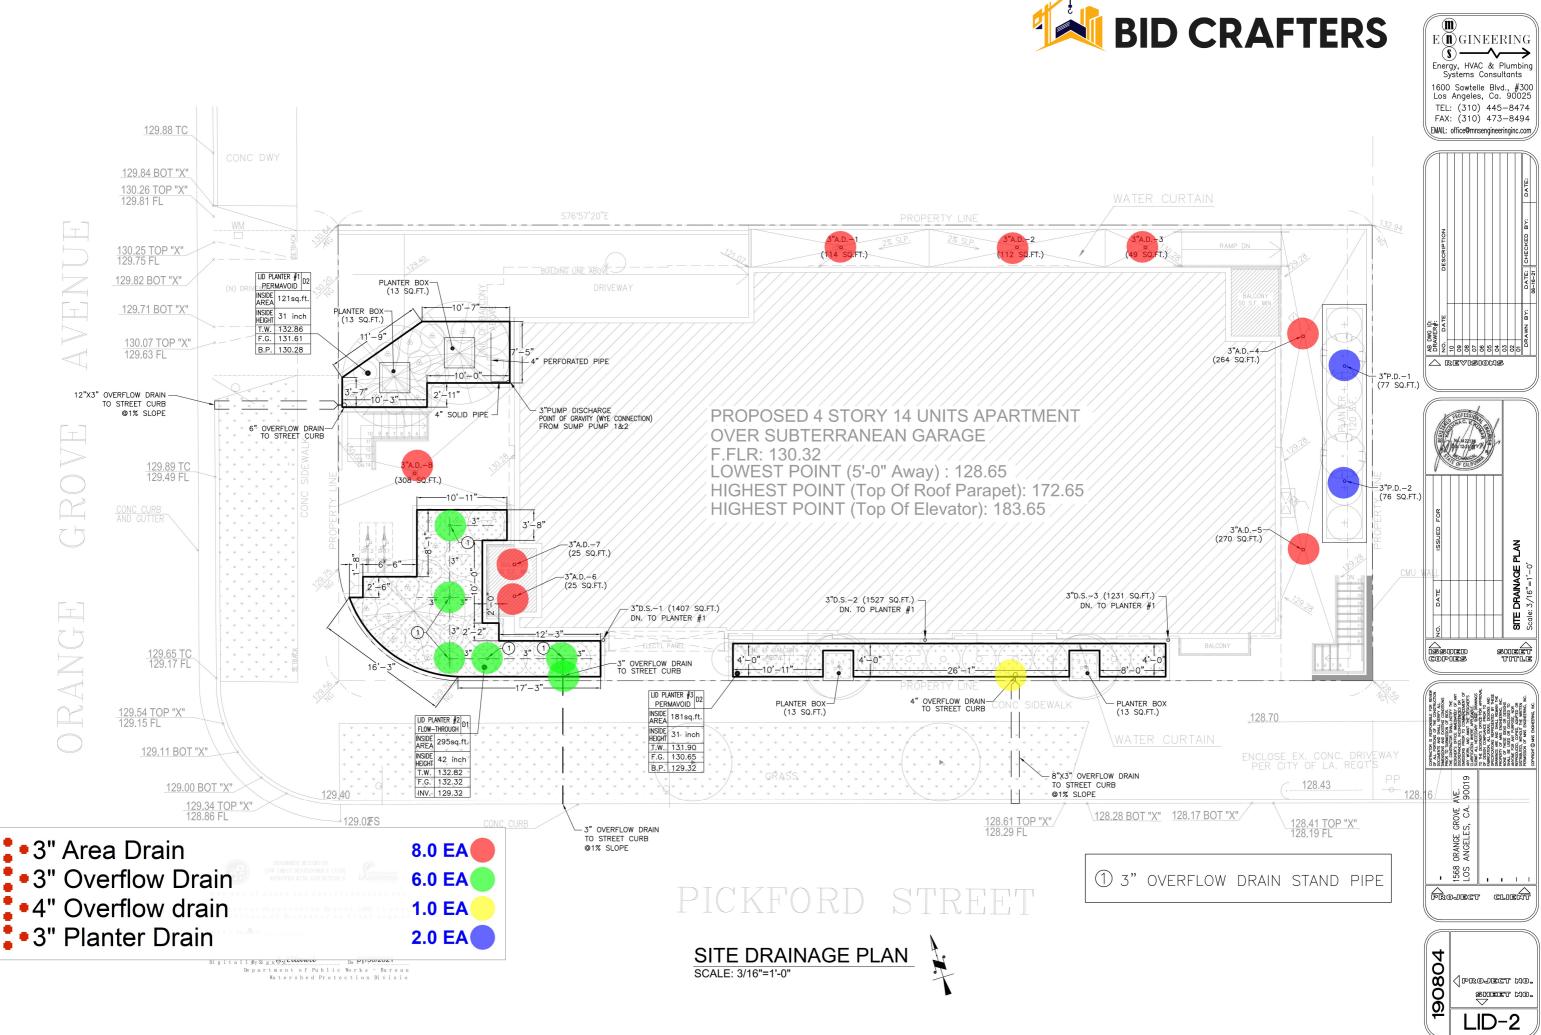



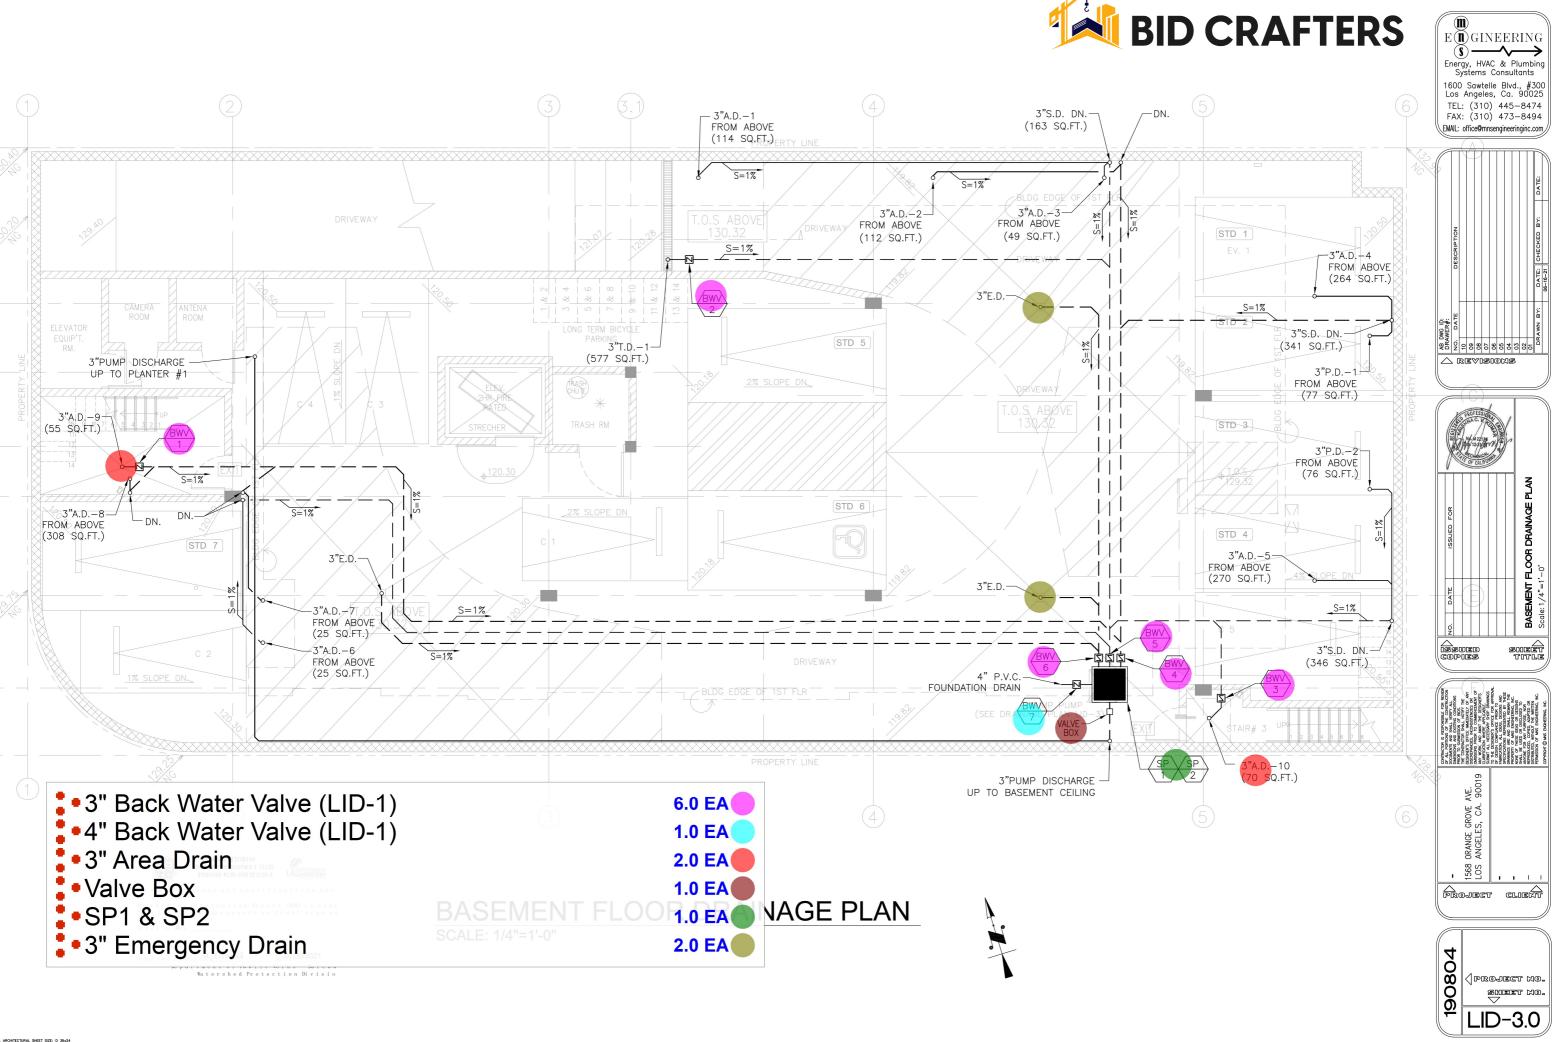





DESIGNED:



WATER EFFICIENT LANDSCAPE WORKSHEET


REFERENCE EVAPOTRANSPIRATION (ETo): 50.1

HYDROZONE / PLANTING DESCRIPTION	PLANT FACTOR (PF)	IRRIGATION METHOD	IRRIGATION EFFICIENCY	ETAF (PF/IE)	LANDSCAPE AREA	ETAF x AREA	
1 / water use plants	.3	DRIP	.81	.37	295	109.15	
2 / water use plants	.3	DRIP	.81	.37	337	124.69	
3 / water use plants	.3	DRIP	.81	.37	478	176.86	
4 / water use plants	.3	DRIP	.81	.37	1200	444	
5 / water use plants	.3	DRIP	.81	.37	110	40.7	
6 / water use plants	.3	DRIP	.81	.37	384	142.08	
7 / water use plants	1.0	DRIP	.81	1.0	217	217	
				SUM	3.021	1,254,48	

ET/

ETAF × AREA	1,254
TOTAL AREA	3,021
AVERAGE ETAF	.41



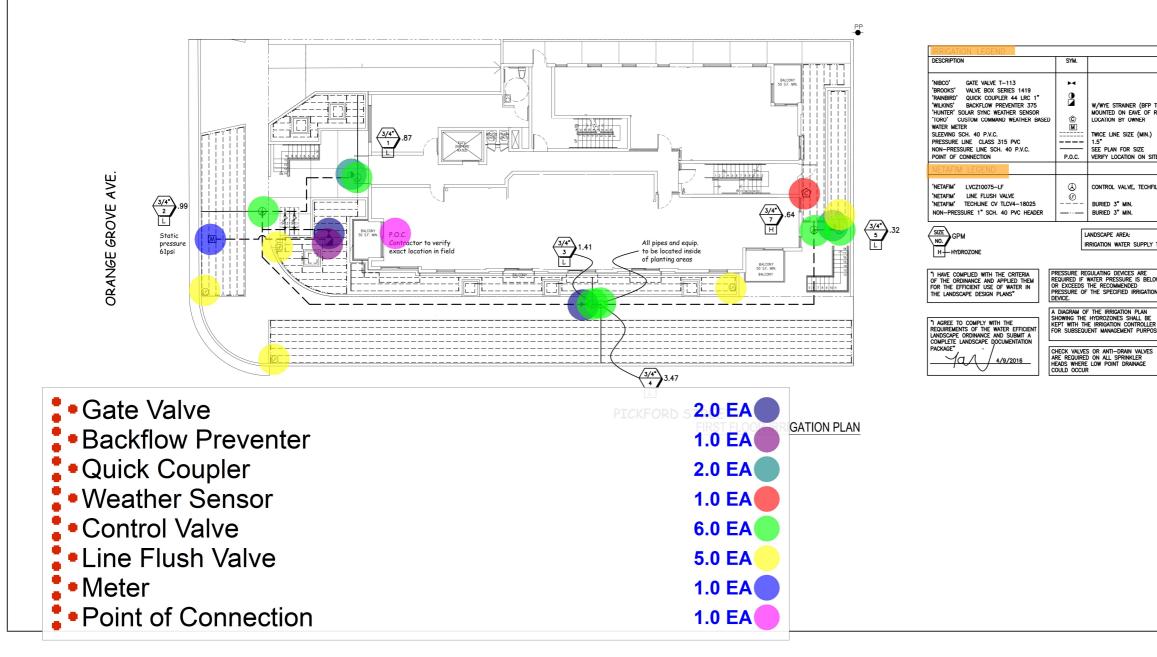

THE SPRINKLER SYSTEM DESIGN IS BASED ON A MINIMUM OPERATING PRESS OF 60 P.S.L AND A MAXIMUM FLOW DEMAND OF 25 G P.M. THE CONTRACTOR SHALL VERIFY WATER PRESSURES PRIOR TO CONSTRUCTION. REPORT MAY BETWEEN WATER PRESSURE INDICATED ON THE DRAWINGS AND THE ACTUAL READING AT THE IRRIGATION POINT OF CONNECTION TO THE ARCHIVER.

DO NOT WILLFULLY INSTALL THE SPRINKLER SYSTEM AS SHOWN ON THE DI WHEN IT IS ORVIOUS IN THE FIELD THAT THERE ARE UNKNOWN OBSTRUCTI GRADE DIFFERENCES IN THE READ. DIMENSIONS EXIST THAT MIGHT NOT H BEEN CONSIDERED IN THE ENGINEERING. SUCH OBSTRUCTIONS OR DIFFE!

ALL SPRINKLER EQUIPMENT NOT OTHERWISE DETAILED OR SPECIFIED SHALL BE INSTALLED AS PER MANUFACTURER'S RECOMMENDATIONS AND SPECIFIC

THE INTENT OF THE CONTRACTOR IS TO PROVIDE 100% COVERAGE TO ALL PLANTING AREAS. AS PART OF THE SCOPE OF WORK, PROVIDE ANY ADDITIONAL HEADS, SPECIAL NOZZLES, OR PATTERNS TO ACHIEVE PROPER COVERAGE WITH MINIMUM OF OVER SPRAY AT NO ADDITIONAL COST TO THE OWNER.

15. INSTALLATION FOR THE CONTROL WIRES SHALL FOLLOW MAINLINE ROUTING.

17. LOCATE VALVE CHART IN CONTROLLER - REDUCE AND ENCASE IN PLASTIC (AS BUILT).

REFER TO GENERAL NOTES FOR ADDITIONAL INFORMATION REGARDING THIS SECTION OF WORK.

16. PROVIDE SLEEVES AS SHOWN ON DRAWING OR AS NEEDED. USE SIZE DIAMETER MIN. SCH. 80 P.V.C. MIN. DEPTH TO TOP OF LINE.

18. GUARANTEE: THE INSTALLED SPRINKLER SYSTEM SHALL BE GUARANTEED FOR A PERIOD OF ONE (1) YEAR FROM THE DATE OF ACCEPTANCE OF THE WORK. SHOULD ANY TROUBLE DEVELOP WITHIN THE THE UNDER SPECIFIED DUE TO INVERTIGAT OR FAULTY MATERIAL ON WORKMARSHIP, THE TROUBLE SHALL BE CORRECTED BY THE CONTINCTOR WITHOUT EDVERSE TO THE OWNER.

NECESSARY REVISIONS

IRRIGATION NOTES

- THIS DESIGN IS DIAGRAMMATIC. ALL PIPING, VALVES, ETC, SHOWN WITHIN PAVED AREAS ARE FOR DESIGN CLARIFICATION ONLY AND SHALL BE INSTALLED IN PI ANTING AREAS WHEREVER DOSSINI F
- 2. SET ALL VALVES AND QUICK COUPLERS NEXT TO WALKS OR PAVED SURFACES ALL SPRINKLER HEADS ARE TO HAVE TRIPLE SWING JOINTS (EXCEPT WHERE NOTED ON PLANS).
- 4. PIPE SIZES SHALL CONFORM TO THOSE SHOWN ON THE DRAWINGS. NO SUBSTITUTIONS OF SMALLER PIPE SIZES SHALL BE PERMITTED, BUT SUBSTITUTION OF LARGER SIZES MAY BE APPROVED. ALL DAMAGED AND REJECTED PIPE SHALL BE REMOVED FROM THE SITE AT THE TIME OF THE SAID REJECTION.
- 5. FINAL LOCATION OF THE AUTOMATIC CONTROLLER SHALL BE APPROVED BY THE LANDSCAPE ARCHITECT AND OWNER.
- 120VAC ELECTRICAL POWER SOURCE AT CONTROLLER LOCATION SHALL BE PROVIDE BY OTHERS
- 7 BEFORE COMMENCING ANY EXCAVATION. THE CONTRACTOR SHALL OBTAIN A BEFORE COMMENCING ANY EXCAVATION, THE CONTRACTOR SHALL BETAIN AN UNDERGROUND SERVICE LEFT ID, NUMBER SY CALLING 14004224133. TWO (2) WORKING DAYS SHALL BE ALLOWED AFTER THE LD NUMBER IS OBTAINED AND BEFORE THE EXCAVATION WORK IS STARTED SO THAT UTILITY OWNERS CAN BE NOTFIED.
- 8. ALL SPRINKLER HEADS SHALL BE SET PERPENDICULAR TO FINISH GRADE UNLESS OTHERWISE SPECIFIED.
- THE CONTRACTOR SHALL FLUSH AND ADJUST ALL SPRINKLER HEADS AND VALVES FOR OPTIMUM COVERAGE WITH MINIMAL OVER SPRAY ONTO WALKS, STREETS, ETC.
- IT IS THE RESPONSIBILITY OF THE IRRIGATION CONTRACTOR TO FAMILIARIZE HIMBELF WITH THE GRADE DIFFERENCES, LOCATION OF WALLS, AND UTLITIES THE IRRIGATION CONTRACTOR SHALL REPAIR OR REPLACE ALL TENS DAMAG HIS WORK. HE SHALL COORDINATE HIS WORK WITH OTHER CONTRACTORS FC LOCATION AND INSTALLATION OF PIPE SELEVES AND LATERALS UNDER ROADI CONTRACT AND INSTALLATION OF PIPE SALEVES AND LATERALS UNDER ROADING THE REPLACEMENT OF THE SALE PIPE AND LATERALS UNDER ROADING THE ROADIN

TAF CALCULATION	
ETAF × AREA	1,254.48
TOTAL AREA	3,021

FTERS)
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ESTIMATED TOTAL WATER USE
3390
3873
5493
13791
1264
4413
6740
38,964
51,611

ro be i Roof	Painted Dark Green)	
E		
lter &	PRESSURE REGULATOR.	
	3,021 SF	
TYPE:	POTABLE WATER SUPPLY	
W F N F	CERTIFICATE OF COMPLETION ILLED OUT AND CERTIFIED BY HE DESIGNER OF THE LANDS LANS, IRRIGATION PLANS OR ICENSED LANDSCAPE CONTRA HE PROJECT	CAPE
E la	N IRRIGATION AUDIT REPORT COMPLETED AT THE TIME OF ISPECTION.	shall be Final

REVISIONS	DATE
1.	7.10.18
2.	11.05.18
3.	11.07.18
4.	4.19.18
5.	8.5.19
6.	10.22.19
7.	11.06.19
8.	12.02.19
9.	



Yael Lir Landscape Architects 1010 Sycamore Ave. Suite 313 South Pasadena, CA 91030 Tel 323.258.5222 Fax 323.258.5333 yael@yaellir.com

14 UNIT 1568 ORANGE GROVE AVE LOS ANGELES, CA 90019


IRRIGATION PLAN



DATE:	MARCH 29, 2018
SCALE:	1/8"=1'-0"
JOB NUMBER:	200618
DRAWN BY:	PATRICIA GUM

L-3



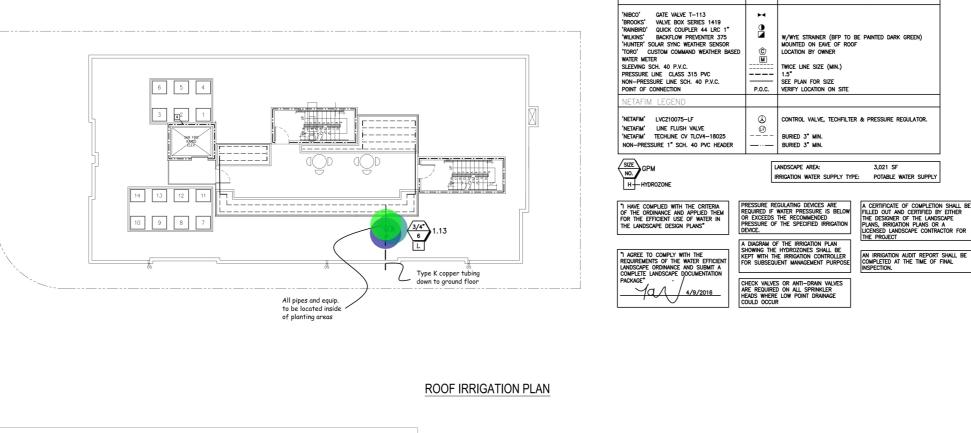

DESCRIPTION

SYM

Control Valve


- •Gate Valve
- Quick Coupler


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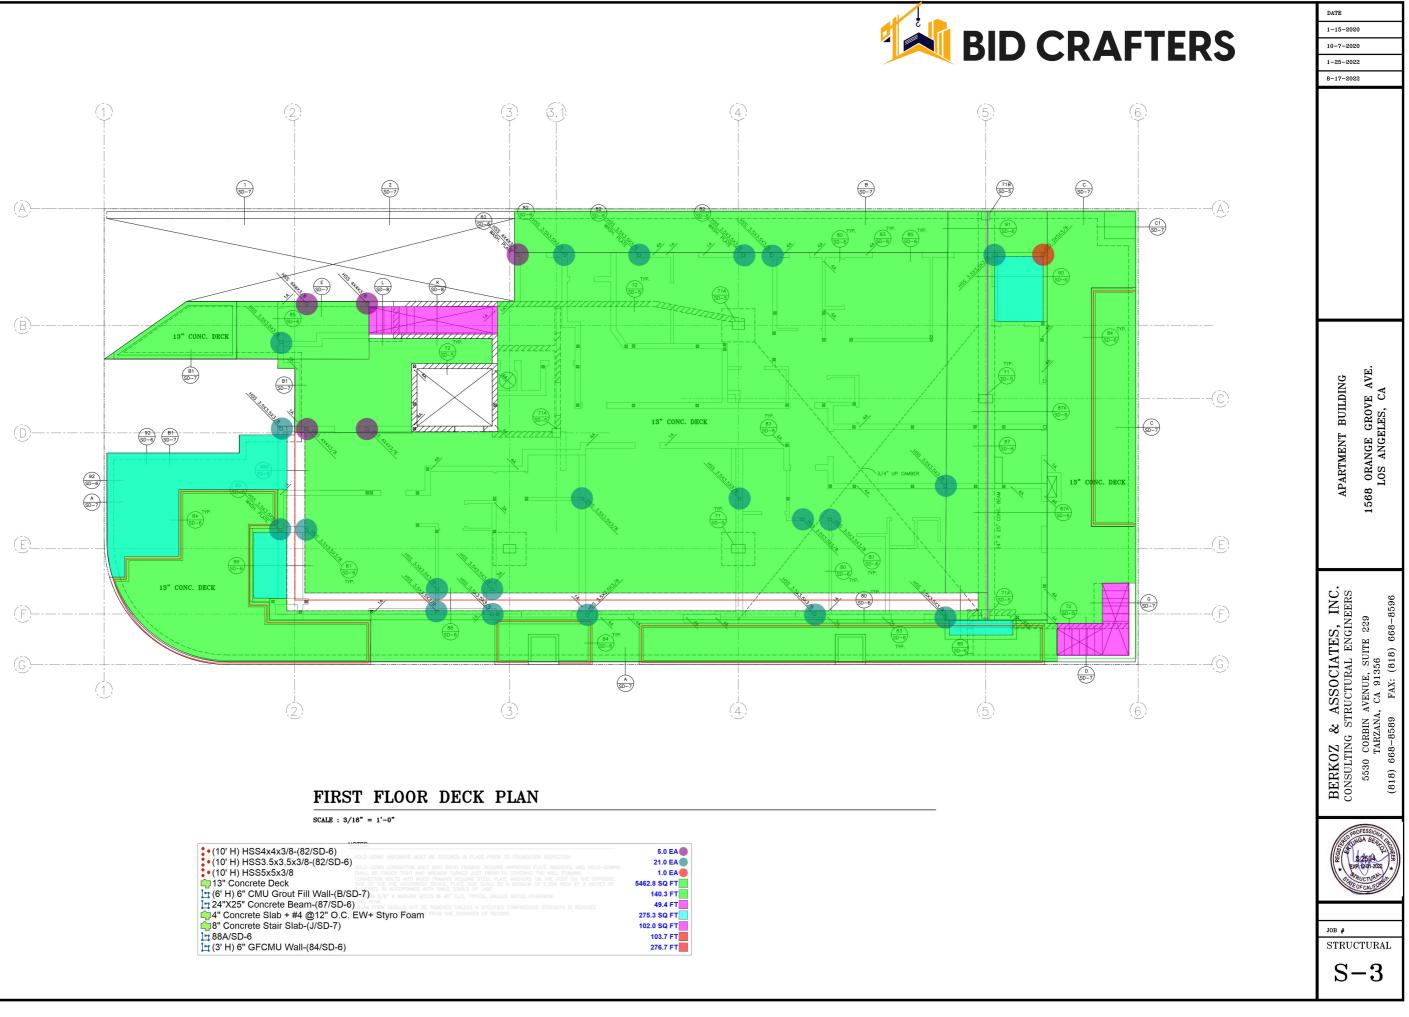
REVISIONS	DATE
1.	7.10.18
2.	11.05.18
3.	11.07.18
4.	4.19.18
5.	8.5.19
6.	10.22.19
7.	11.06.19
8.	
9.	

ASLA Yael Lir Landscape Architects 1010 Sycamore Ave. Suite 313 South Pasadena, CA 91030 Tel 323.258.5222 Fax 323.258.5333 yael@yaellir.com 14 UNIT 1568 ORANGE GROVE AVE. LOS ANGELES, CA 90019 ROOF IRRIGATION PLAN LANDSCAPE <u>1a</u> Signature 12-31-19 Renewal Date DATE: MARCH 29, 2018 SCALE: 1/8"=1'-0 JOB NUMBER: 200618 DRAWN BY: PATRICIA GUM

L-4




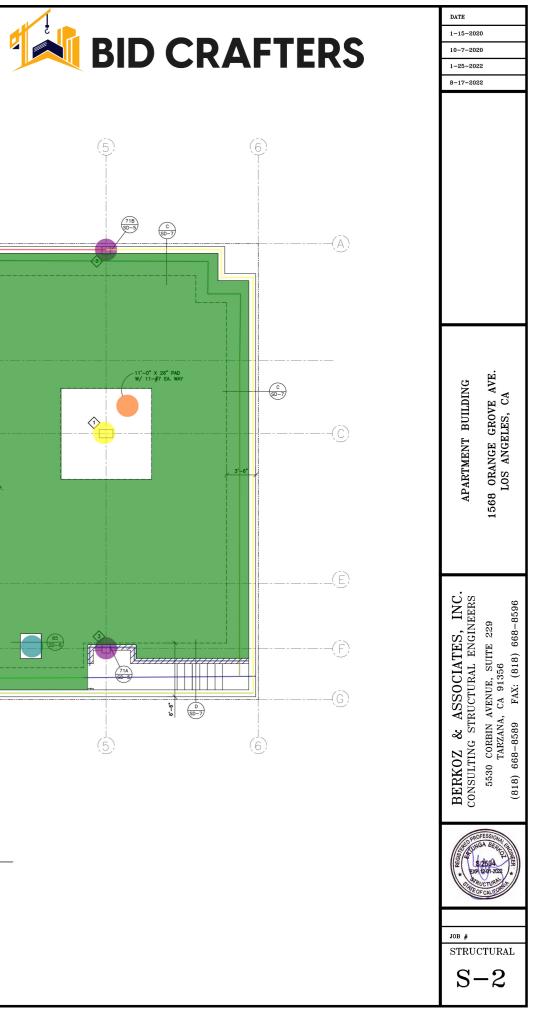

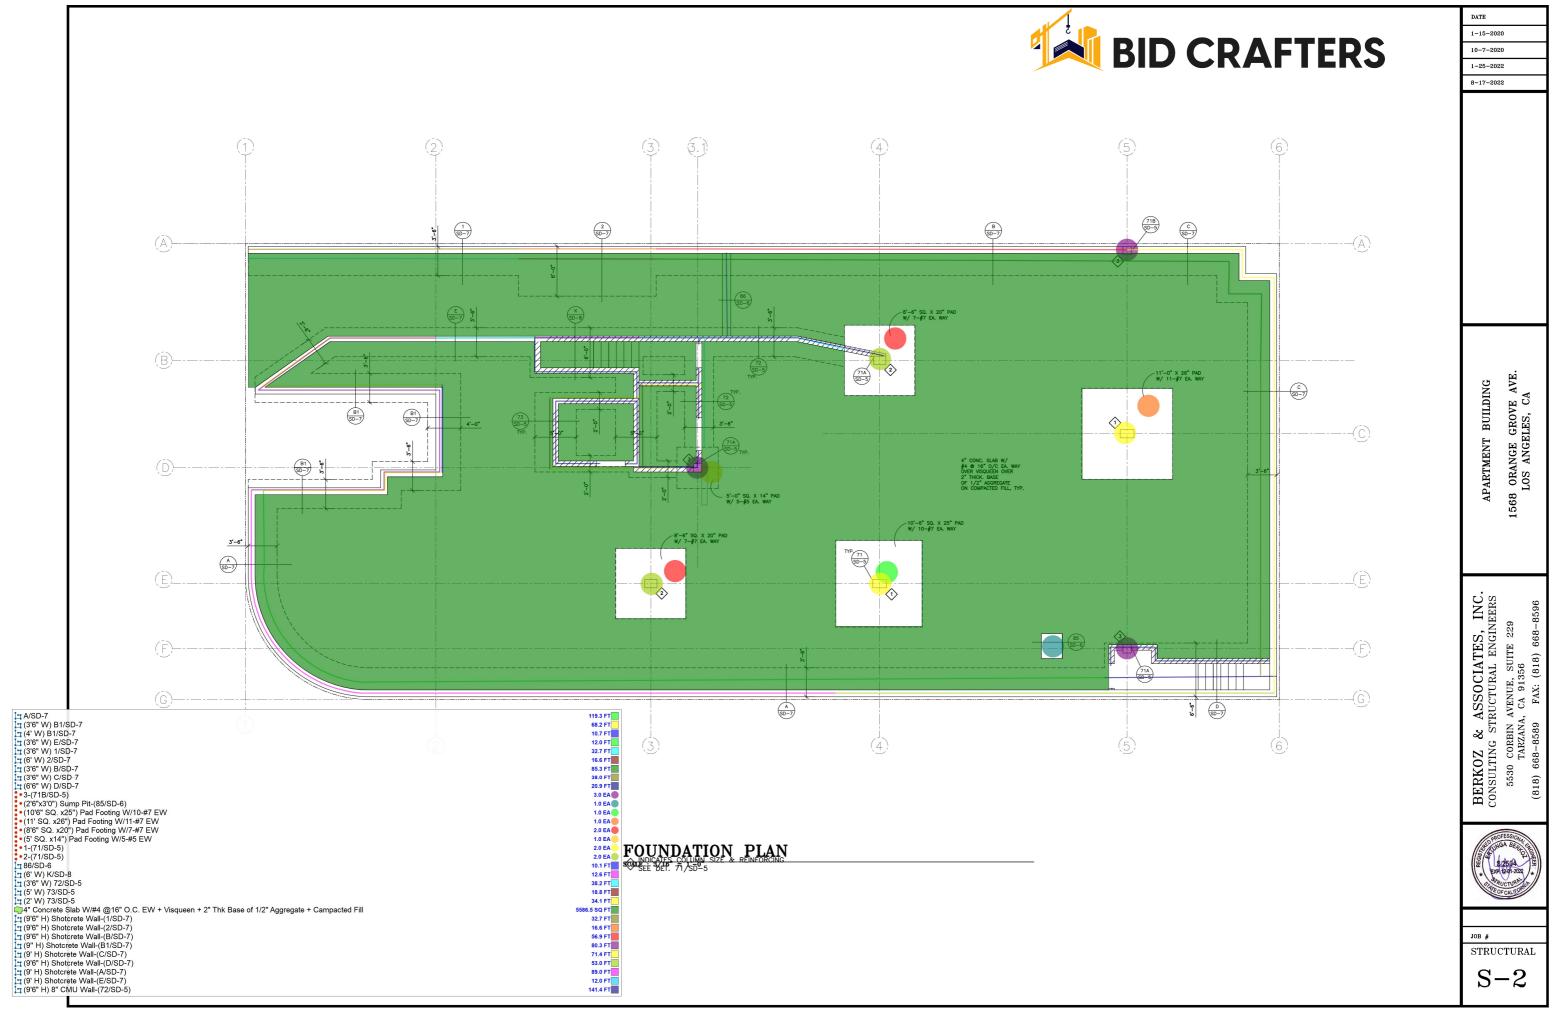


• (10' H) HSS4x4x3/8-(82/SD-6)	5.0 EA
• (10' H) HSS3.5x3.5x3/8-(82/SD-6)	21.0 EA
• (10' H) HSS5x5x5x3/8	1.0 EA
13" Concrete Deck	5462.8 SQ FT
🔄 (6' H) 6" CMU Grout Fill Wall-(B/SD-7) start a memory bacts of the over the start of the overthe overhead ov	140.3 FT
24"X25" Concrete Beam-(87/SD-6)	49.4 FT
4" Concrete Slab + #4 @12" O.C. EW+ Styro Foam	275.3 SQ FT
58" Concrete Stair Slab-(J/SD-7)	102.0 SQ FT
1 88A/SD-6	103.7 FT
(3' H) 6" GFCMU Wall-(84/SD-6)	276.7 FT




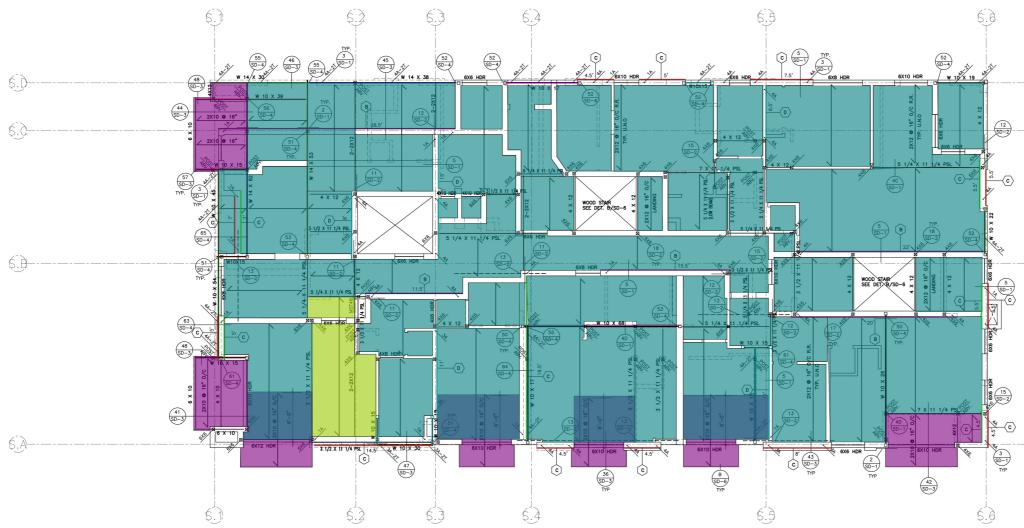


L: W10x15 L: W10x54 L: W10x45 L: W10x45 L: W14x82 Q: 2x10 Joists	SECOND FLOOR FRAMING PLAN SCAR : 19/15" = 1'-5" @16" O.C	16.1 FT 12.2 FT 10.6 FT 21.1 FT 472.4 SQ FT
	O.C., Grade #2	3237.1 SQ FT
L 2X12 @12" L W10x39	O.C., Grade #2	110.2 SQ FT 13.6 FT
L W14x30		11.8 FT
L= W14x53		21.0 FT
L= W14x38		18.0 FT
I=: W10x17		9.1 FT
L= W10x15 L= W10x19		5.8 FT
L W10x13		5.6 FT
🗄 W10x30		6.6 FT
L= W10x17		14.1 FT
L= W10x68		18.5 FT
L= W10x26 L= (10' H) C		15.8 FT 76.3 FT
L (10 H) C		49.1 FT
(10'H) B		98.8 FT
🕒 (10' H) D		51.2 FT




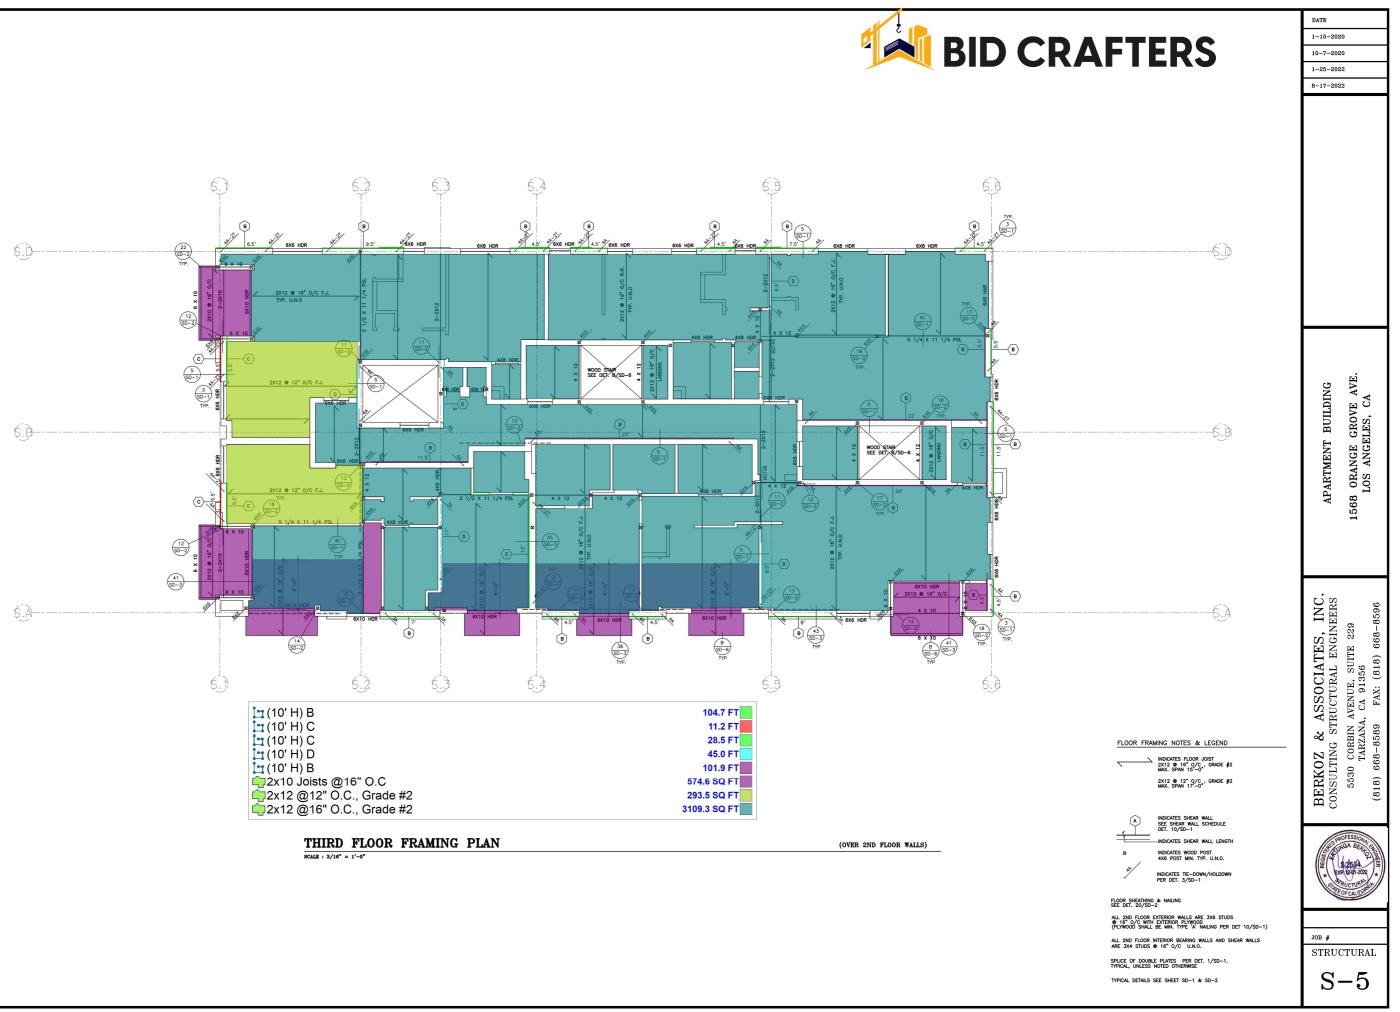

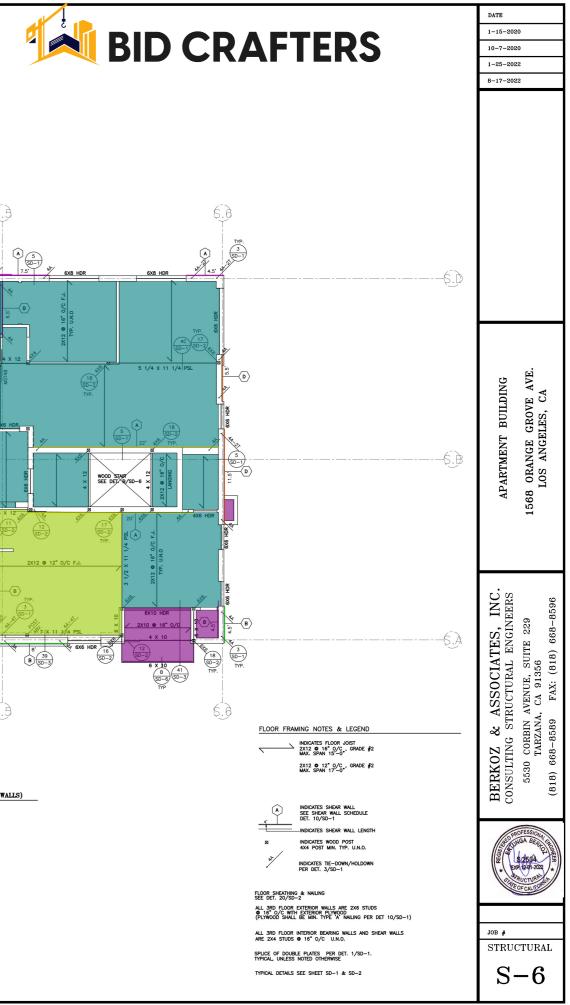


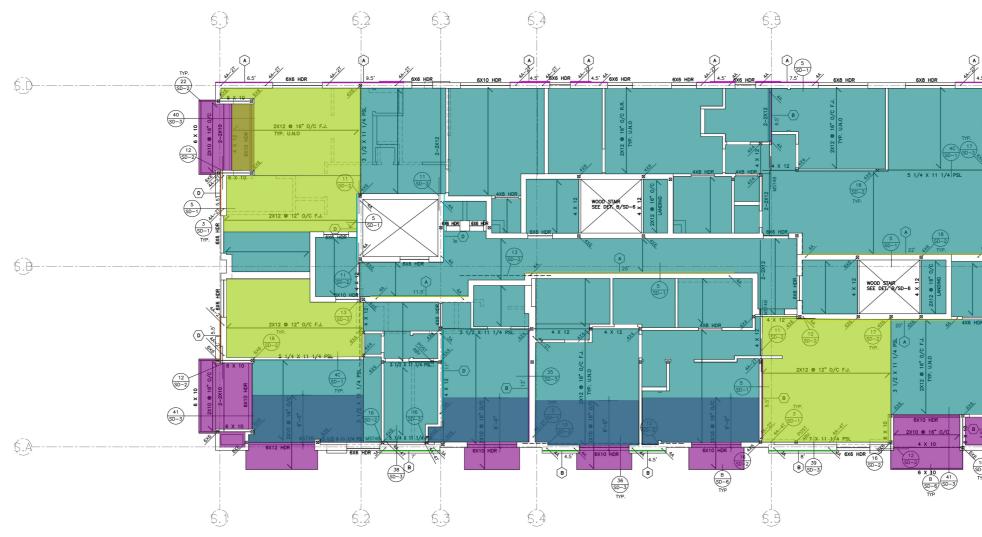



OURTH FLOOR FRAMING PLAN ALE : 3/10" = 1'-0"	(OVER 3RD FLOOP
L= (10' H) A	58.5 FT
(10' H) B	29.3 FT
	28.5 FT
(10' H) D	27.9 FT
(10' H) A	79.8 FT
(10' H) B	34.8 FT
2x10 Joists @16" O.C	551.9 SQ FT
📫 2x12 @16" O.C., Grade #2	2760.7 SQ FT
	641.7 SQ FT

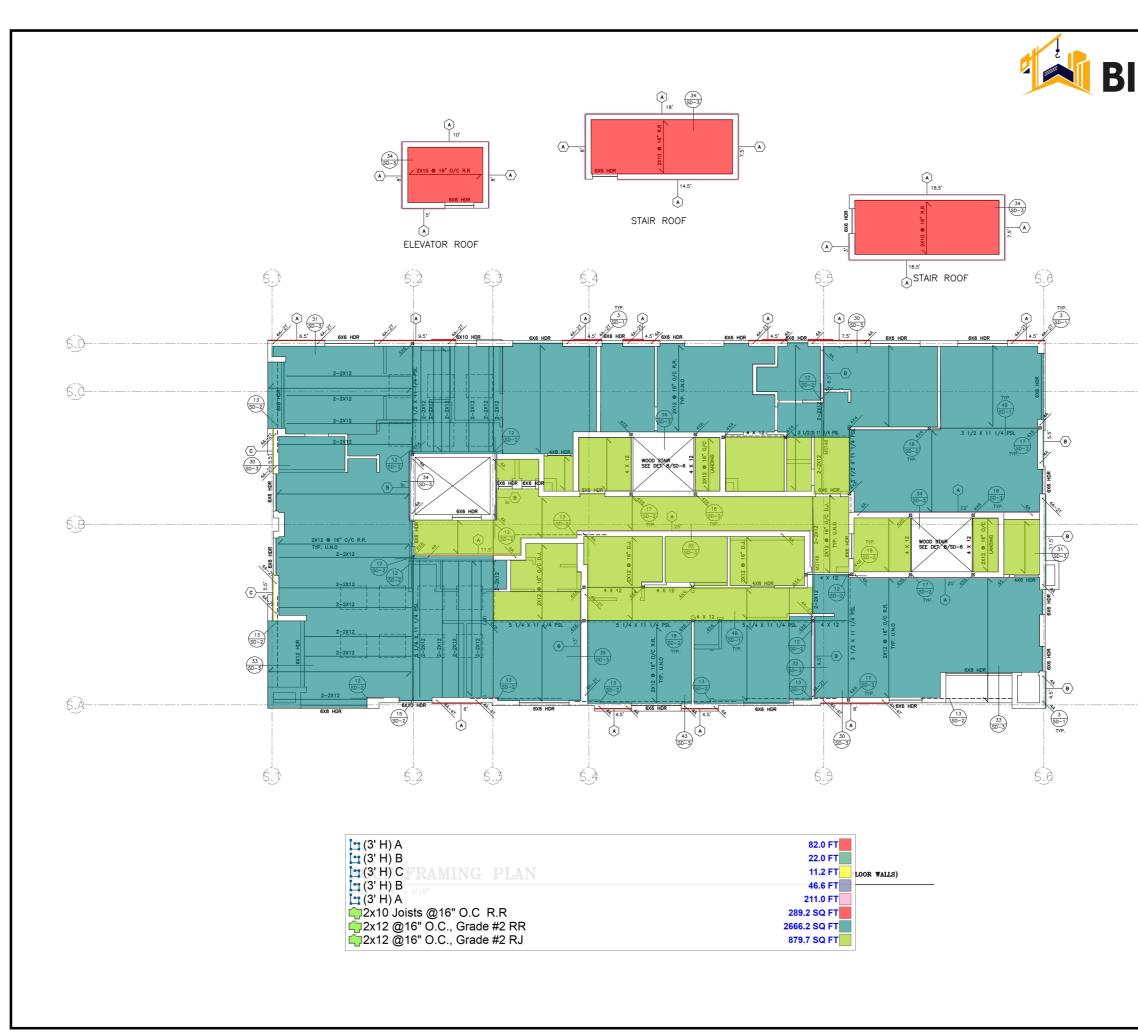

D CRAFTERS	DATE 1-15-2020 10-7-2020 1-25-2022 8-17-2022
6.D 6.C	APARTMENT BUILDING 1568 ORANGE GROVE AVE. LOS ANGELES, CA
ROOF FRAMING NOTES & LEGEND MOCATES ROOF PATER X12 GRACE \$2 @ 16" 0/C, TYP. U.N.O. WICKTES SHOAF PATER X12 GRACE \$2 @ 16" 0/C, TYP. U.N.O. WICKTES SHOAF WALL SCHEDULE X12 GRACE \$2 @ 16" 0/C, TYP. U.N.O. WICKTES SHOAF WALL SCHEDULE X12 GRACE \$2 @ 16" 0/C, TYP. U.N.O. WICKTES SHOAF WALL SCHEDULE X12 GRACE \$2 @ 16" 0/C, TYP. U.N.O. WICKTES SHOAF WALL SCHEDULE X12 GRACE \$10, 50-0" WICKTES SHOAF WALL SCHEDULE X12 GRACE \$10, 50-0" WICKTES TE-DOWN/HOLDOWN PER DET. 3/50-1 ROOF DECK SHEATHING & NULING (BLOCKED DIAPHRAGM) SEE DET. 15/50-1 X14 GTH FLOOR DETERIOR WALLS ARE \$2K6 STUDS 0 (FLYMOOD SHALL BE MIN. TYPE 'X MULING PER DET 10/SD-1) (FLYMOOD SHALL BE MIN. TYPE 'X MULING PER DET 10/SD-1) ALL 4TH FLOOR NITERIOR BEARING WALLS AND SHEAR WALLS ALL 4TH FLOOR NITERIOR BEARING	BERKOZ & ASSOCIATES, INC. BERKOZ & ASSOCIATES, INC. C ONSULTING STRUCTURAL ENGINEERS 5530 CORBIN AVENUE, SUITE 229 TARZANA, CA 91356 (818) 668-8589 FAX: (818) 668-8596

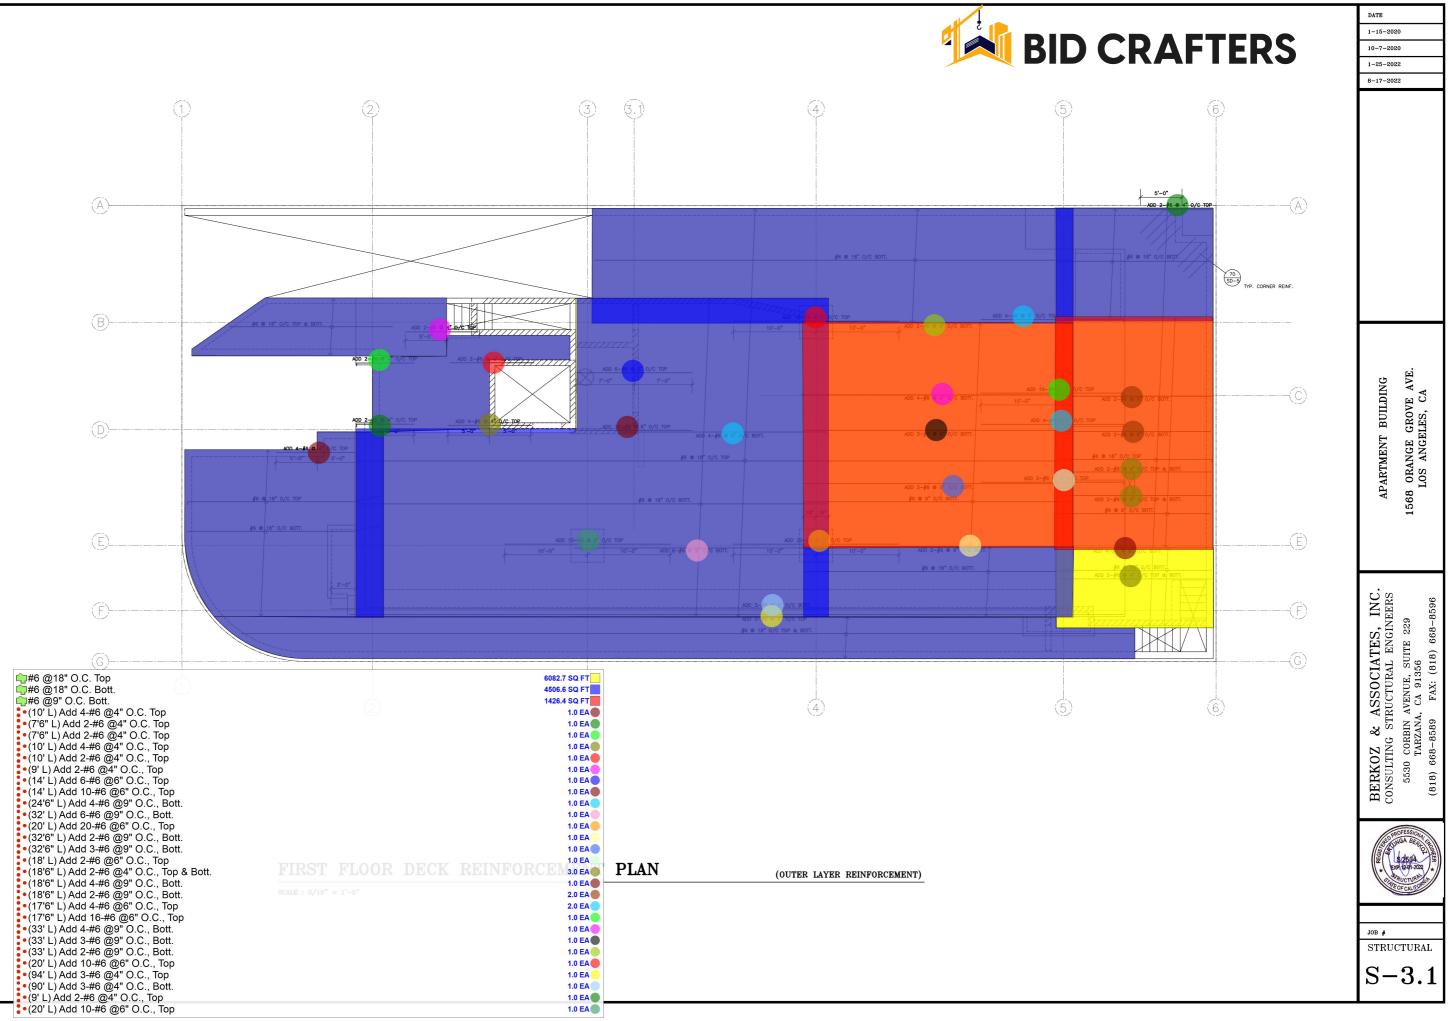

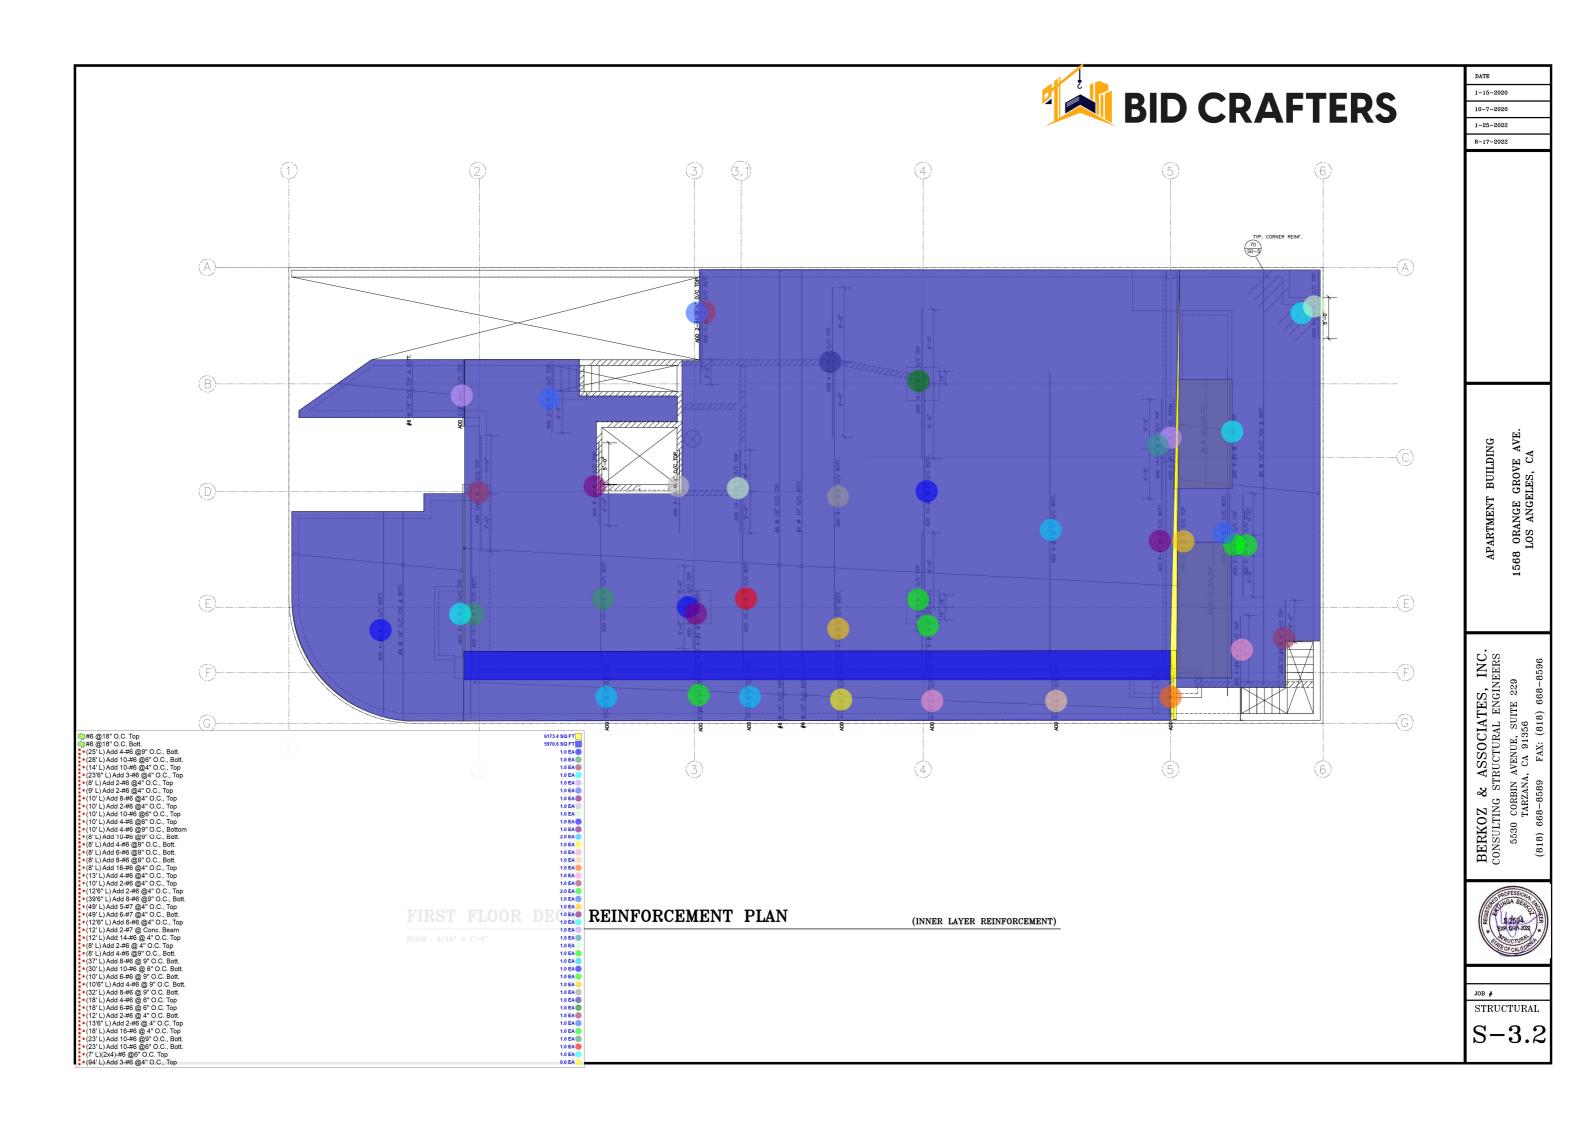

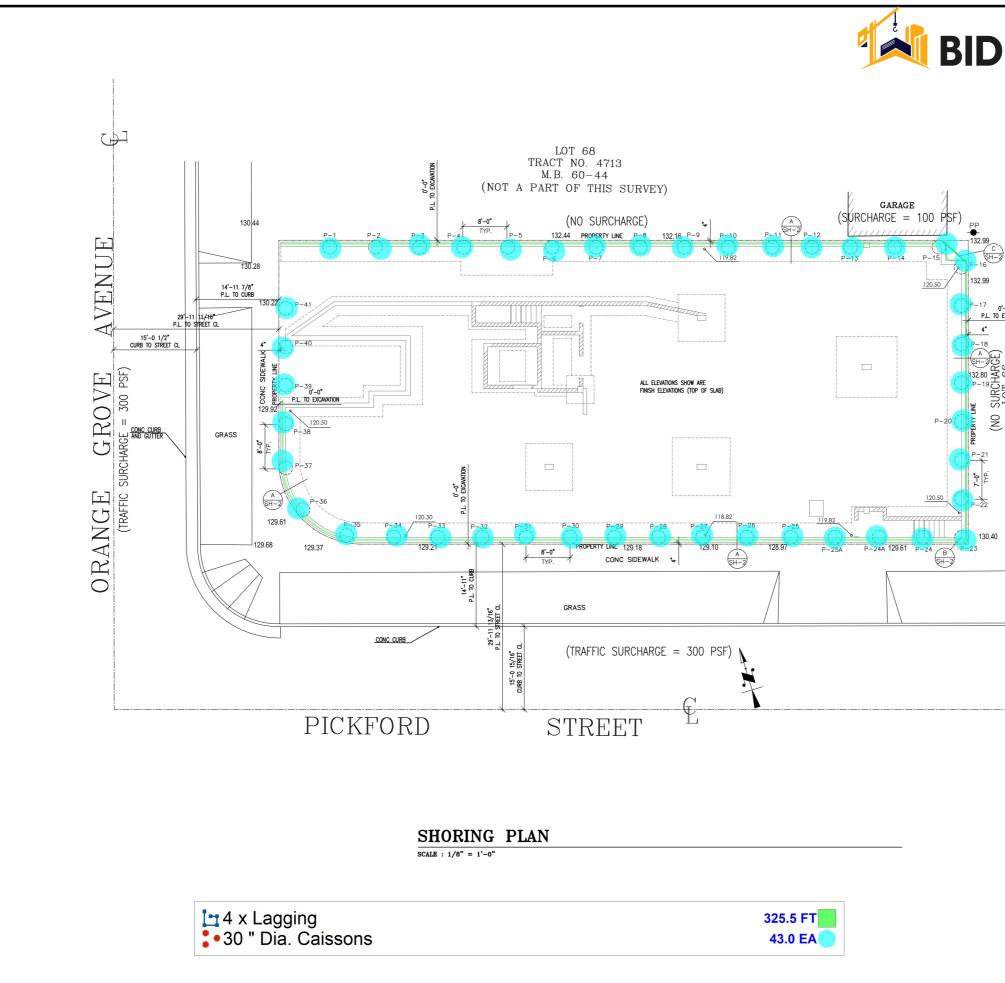

	DATE 1-15-2020	
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CRAFIERS	9-24-2021	
	12-17-202	:1
	1-25-2022 8-17-2022	
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